

SYMBOLS


	DOUBLE BIT BOLLARD
	STANDARD BOLLARD
	LIGHT DUTY CLEAT
	CLEAT
100T	BOLLARD OR CLEAT LOADING (TONS)
	-30 FOOT CONTOUR
	-35 FOOT CONTOUR

NOTES



1. HYDROGRAPHIC INFORMATION SHOWN PROVIDED BY F.M. BECK, INC. ONE MAIN STREET, YARMOUTH, ME. 04095. SURVEY PERFORMED APRIL 2012.
2. DEPTHS ARE BASED ON MEAN LOWER LOW WATER (MLLW) AND ARE SHOWN IN FEET.
3. CONTOUR INTERVAL IS ONE FOOT.
4. BOLLARD AND CLEAT LOADING BASED ON PLAN SET TITLED, "BATH IRON WORKS CORPORATION PORTLAND FACILITY" DATED, APRIL, 1982. PROJECT NO. 3995. BY C.E MAGUIRE, INC. WALTHAM, MA.

PRELIMINARY

<p>CITY OF PORTLAND MAINE PUBLIC BUILDINGS DIVISION</p>			
<p>MAINE STATE AND OCEAN GATEWAY PIERS SITE PLAN</p>			
<p>TEC ASSOCIATES CONSULTING ENGINEERS 46 SAWYER STREET SOUTH PORTLAND, MAINE 04106</p>			
SCALE NTS		DATE 23 APRIL 2012	
JOB NUMBER 1201-1	DRAWN BY J.D.L.	DESIGNED BY	DRAWING NO. 1 OF 1

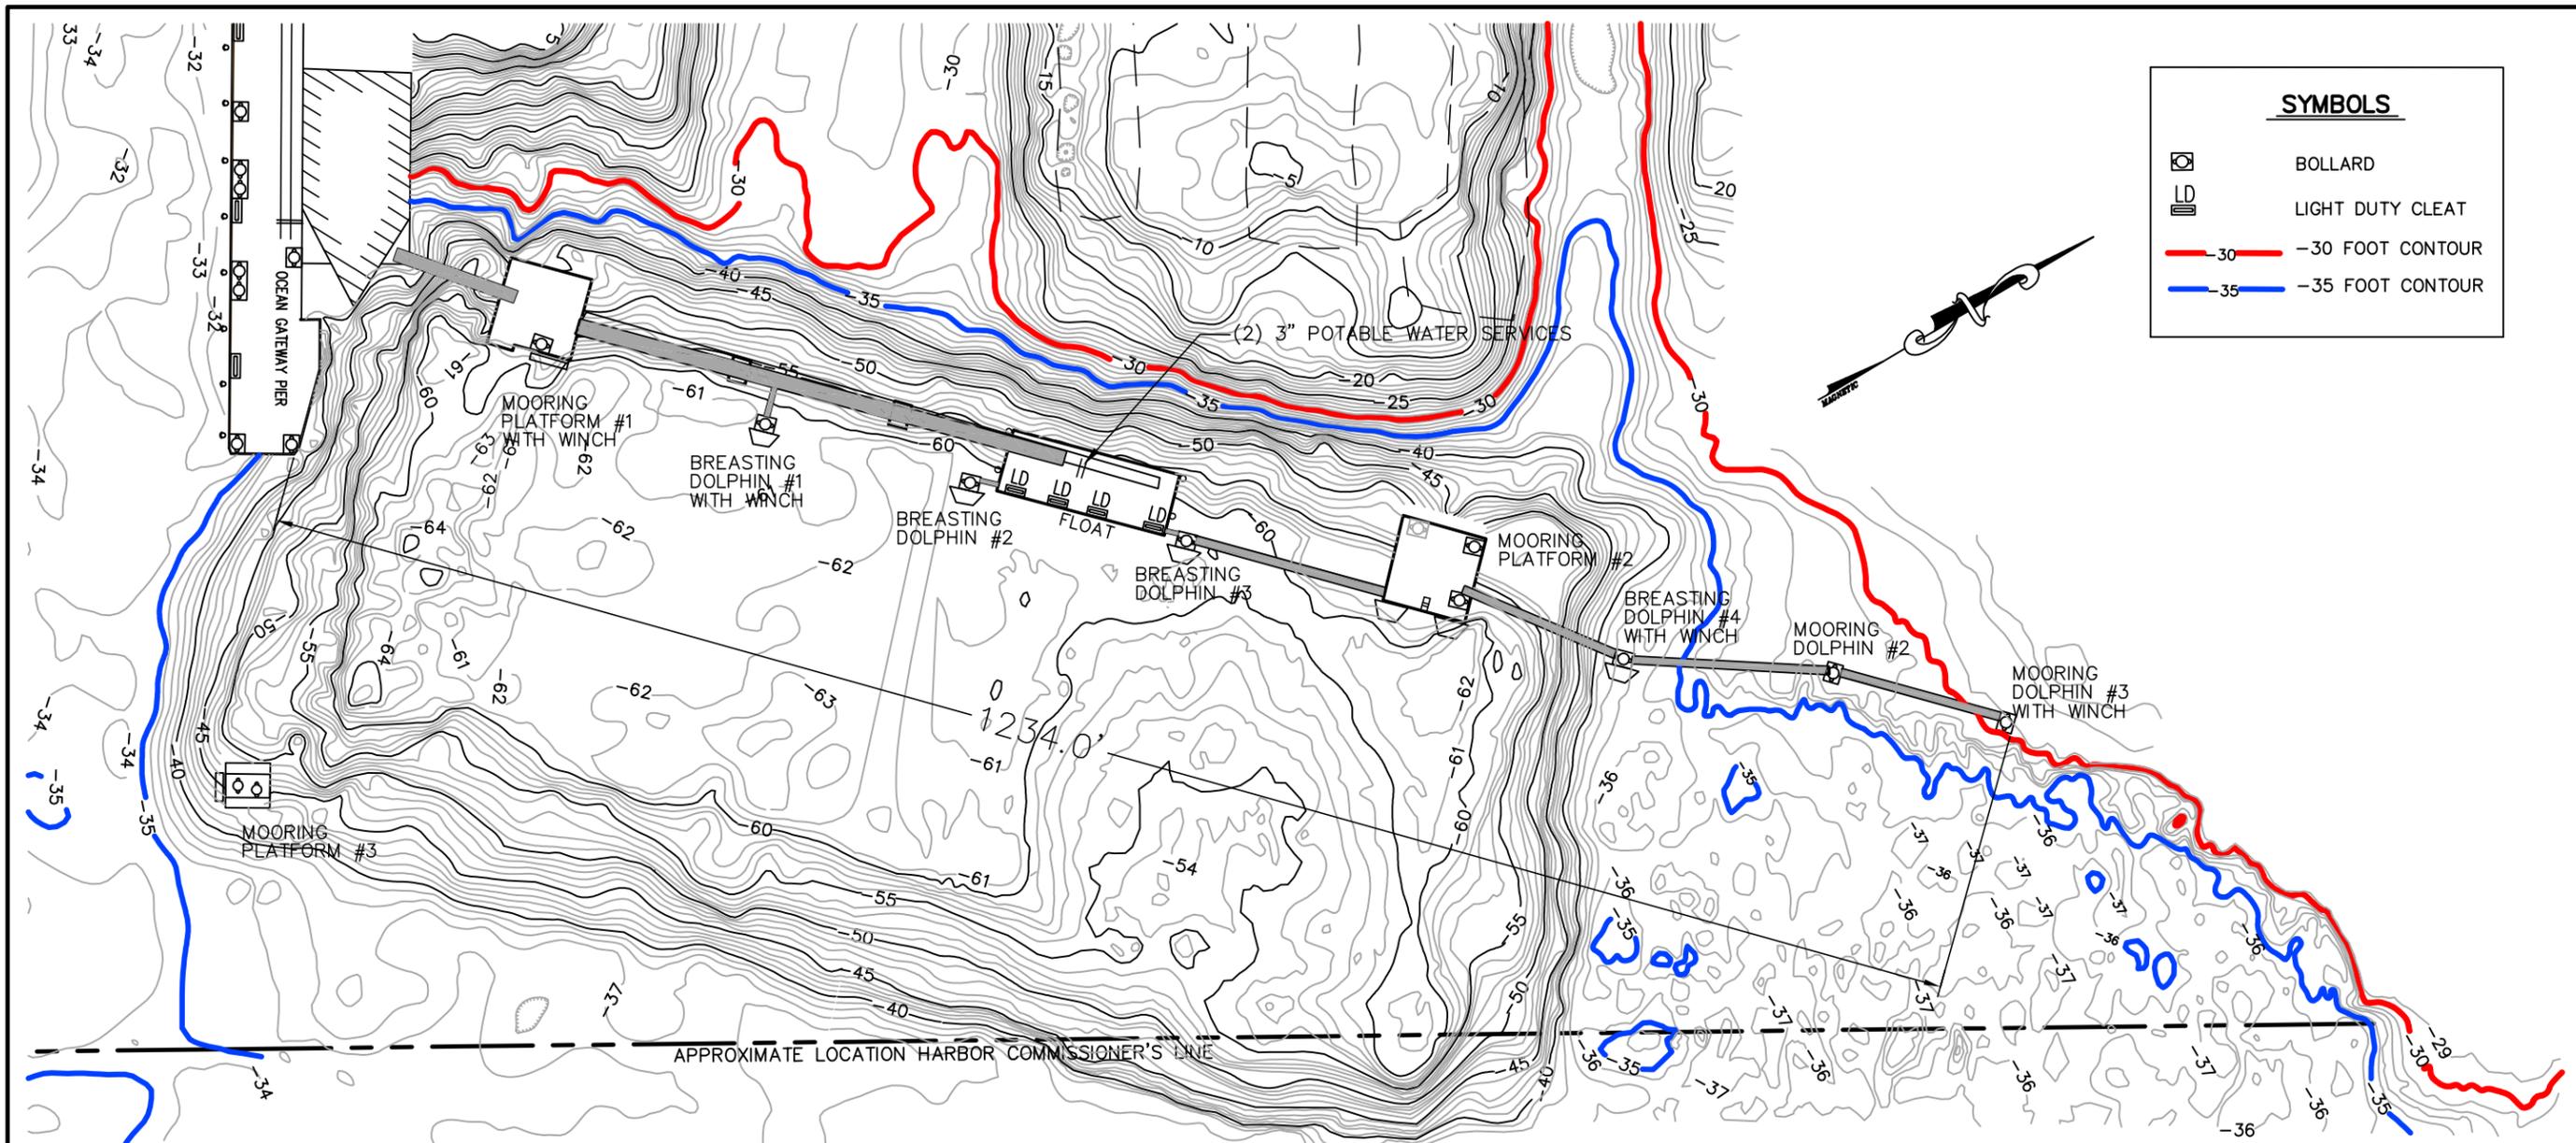

SYMBOLS	
	BOLLARD
	LIGHT DUTY CLEAT
	-30 FOOT CONTOUR
	-35 FOOT CONTOUR

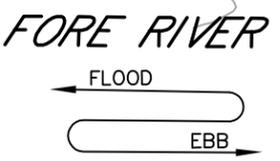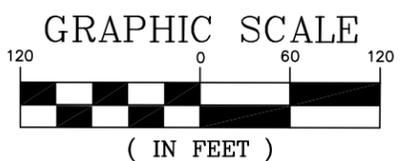

NOTES
 1. HYDROGRAPHIC INFORMATION SHOWN PROVIDED BY F.M. BECK, INC. ONE MAIN STREET, YARMOUTH, ME. 04095. SURVEY PERFORMED DECEMBER 2010 AND FROM DIGITIZED IMAGE OF POST DREDGE PLAN PROVIDED BY REED AND REED, INC. DATED, 5/11/2012.
 2. DEPTHS ARE BASED ON MEAN LOWER LOW WATER (MLLW) AND ARE SHOWN IN FEET.

PRELIMINARY

CITY OF PORTLAND MAINE PUBLIC BUILDINGS DIVISION			
OCEAN GATEWAY MEGA BERTH SITE PLAN			
TEC ASSOCIATES 46 SAWYER STREET SOUTH PORTLAND, MAINE 04106		CONSULTING ENGINEERS 04106	
SCALE NTS		DATE 7 AUGUST 2012	
JOB NUMBER 1201-1	DRAWN BY J.D.L.	DESIGNED BY	DRAWING NO. 1 OF 1